SOLANO COMMUNITY COLLEGE

4000 SUISUN VALLEY ROAD, FAIRFIELD, CA 94534

REROOFING OF BUILDING 1500

4000 SUISUN VALLEY ROAD, FAIRFIELD, CA 94534

CODE SUMMARY & REGULATIONS

AS A FACILITY WHICH COMES UNDER THE APPROVAL AND AUTHORITY OF THE DIVISION OF THE STATE ARCHITECT OFFICE OF REGULATION SERVICES (DSA), THIS PROJECT IS SUBJECT TO DRAWING AND JOB SITE REVIEW BY A REPRESENTATIVE OF DSA.

ADMINISTRATIVE REQUIREMENTS (PARTIAL LISTING ONLY FROM CHAPTER 4, PART 1, TITLE 24, C.C.R)

- 1. A COPY OF PARTS 1 AND 2, TITLE 24, C.C.R. AND ALL SECTIONS OF THE CALIFORNIA BUILDING CODE (9 VOLUMES) SHALL BE KEPT ON
- . ALL CONSTRUCTION CHANGE DOCUMENTS AND ADDENDA TO BE SIGNED BY THE ARCHITECT OF RECORD AND THE OWNER AND

- 5. CONTRACTOR, INSPECTOR, ARCHITECT OF RECORD AND ENGINEERS SHALL SUBMIT VERIFIED REPORTS (DSA 6AE) IN ACCORDANCE
- WITH SECTION 4-336 AND 4-343, PART 1, TITLE 24

NON-COMPLYING CONSTRUCTION FOR ALTERATION PROJECTS, STATEMENTS SIMILAR TO THE ONE NOTED IN SECTION 4-317 (C), PART 1 TITLE 24, C.C.R. IS TO BE INCLUDED ON THE COVER DRAWINGS.

TO BE IN ACCORDANCE WITH TITLE 24, CALIFORNIA CODE OF REGULATIONS. UPON DISCOVERY OF NON-COMPLYING EXISTING CONDITIONS OR SEPARATE SET OF CONSTRUCTION DOCUMENTS ADDRESSING THE NECESSARY REMEDIAL SCOPE OF WORK SHALL BE SUBMITTED TO ANI APPROVED BY THE OWNER, CLIENT, ARCHITECT AND DSA BEFORE PROCEEDING WITH THE WORK.

GOVERNING CODES

- 2016 CALIFORNIA ADMINISTRATIVE CODE, TITLE 24, PART • 2016 CALIFORNIA BUILDING CODE, TITLE 24, PART 2, VOLUMES 1 AND 2
- 2016 CALIFORNIA ELECTRICAL CODE, TITLE 24, PART 3 2016 CALIFORNIA MECHANICAL CODE, TITLE 24, PART 4
- 2016 CALIFORNIA PLUMBING CODE, TITLE 24, PART 5
- 2016 CALIFORNIA ENERGY CODE, TITLE 24, PART 6 2016 CALIFORNIA FIRE CODE, TITLE 24, PART 9
- 2016 CALIFORNIA EXISTING BUILDING CODE, TITLE 24, PART 10
- 2016 CALIFORNIA GREEN BUILDING STANDARDS, TITLE 24, PART 11
- 2016 CALIFORNIA REFERENCED STANDARDS, TITLE 24, PART 12
- TITLE 19 CCR STATE FIRE MARSHAL REGULATIONS ACI 318-14 CODE AND COMMENTARY
- 2010 ADA STANDARDS FOR ACCESSIBLE DESIGN
- AISC MANUAL OF STEEL CONSTRUCTION, 14TH EDITION
- 2015 ANSI/AWC NDS-15 REVISED NATIONAL DESIGN SPECIFICATION FOR WOOD CONSTRUCTION
- ASTM STANDARDS CHANGES (EXAMPLE: ASTM E648-04 STANDARD TEST METHOD FOR CRITICAL RADIANT FLUX OF FLOOR) • 2012 ICC 300-12 STANDARDS ON BLEACHERS, FOLDING TELESCOPIC SEATING & GRANDSTANDS
- 2016 NFPA 13-16 AUTOMATIC SPRINKLER SYSTEMS, WITH 2016 CBC AMENDMENTS 2013 NFPA 14-13 INSTALLATION OF STANDPIPE, PRIVATE HYDRANT AND HOSE SYSTEMS, WITH 2016 CBC AMENDMENTS
- 2013 NFPA 17-13 DRY CHEMICAL EXTINGUISHING SYSTEMS
- 2013 NFPA 17A-13 WET CHEMICAL EXTINGUISHING SYSTEMS • 2016 NFPA 20-16 INSTALLATION OF STATIONARY PUMPS FOR FIRE PROTECTION
- 2013 NFPA 22-13 WATER TANKS FOR PRIVATE FIRE PROTECTION
- 2016 NFPA 24-16 INSTALLATION OF PRIVATE FIRE SERVICE MAINS AND THEIR APPURTENANCES, WITH 2016 CBC AMENDMENTS 2008 NFPA 25-13CA INSPECTION, TESTING, MAINTENANCE OF WATER-BASED FIRE PROTECTION SYSTEMS, CALIFORNIA EDITION
- 2016 NFPA 72-16 NATIONAL FIRE ALARM CODE, WITH 2016 CBC AMENDMENTS • 2016 NFPA 110-16 EMERGENCY AND STANDBY POWER SYSTEMS
- 2015 NFPA 2001-15 CLEAN AGENT FIRE EXTINGUISHING SYSTEMS, WITH 2016 CBC AMENDMENTS • UL STANDARD CHANGES (EXAMPLE: 2005 UL 38 MANUAL OPERATING SIGNAL BOXES)
- 2003 UL 464-03 AUDIBLE SIGNAL APPLIANCES
- 1999 UL 521-99 HEAT DETECTORS FOR FIRE PROTECTIVE SIGNALING SYSTEMS • 2002 UL 1971 SIGNALING DEVICES FOR HEARING IMPAIRED

EQUIPMENT ANCHORAGE NOTES ALL MECHANICAL, PLUMBING AND ELECTRICAL COMPONENTS SHALL BE ANCHORED AND INSTALLED PER DETAILS ON DSA APPROVED CONSTRUCTION DOCUMENTS. WHERE NO DETAIL IS INDICATED, THE FOLLOWING COMPONENTS SHALL BE ANCHORED OR BRACED TO MEET

- CHAPTER 6 AND 30:
- .. ALL PERMANENT EQUIPMENT AND COMPONENTS !. TEMPORARY OR MOVABLE EQUIPMENT THAT IS PERMANENTLY ATTACHED (E.G. HARD WIRED) TO THE BUILDING UTILITY SERVICES SUCH 📗

THE FORCE AND DISPLACEMENT REQUIREMENTS PRESCRIBED IN 2016 CBC, SECTIONS 1616A.1.18 THROUGH 1616A.1.26 AND ASCE 7-10

3. MOVABLE EQUIPMENT WHICH IS STATIONED IN ONE PLACE FOR MORE THAN 8 HOURS AND HEAVIER THAN 400 POUNDS ARE REQUIRED

THE ATTACHMENT OF THE FOLLOWING MECHANICAL AND ELECTRICAL COMPONENTS SHALL BE POSITIVELY ATTACHED TO THE STRUCTURE, BUT NOT BE DETAILED ON THE PLANS. THESE COMPONENTS SHALL HAVE FLEXIBLE CONNECTIONS PROVIDED BETWEEN THE COMPONENTS AND ASSOCIATED DUCTWORK, PIPING AND CONDUIT:

- 1. COMPONENTS WEIGHING LESS THAN 400 POUNDS AND HAVE A CENTER OF MASS LOCATED 4 FEET OR LESS ABOVE THE ADJACENT FLOOR OR ROOF LEVEL THAT DIRECTLY SUPPORT THE COMPONENT.
- . COMPONENTS WEIGHING LESS THAN 20 POUNDS, OR IN THE CASE OF DISTRIBUTED SYSTEMS, LESS THAN 5 POUNDS PER FOOT, WHICH ARE SUSPENDED FROM A ROOF OR FLOOR OR HUNG FROM A WALL.

FOR THOSE ELEMENTS THAT DO NOT REQUIRE DETAILS ON THE APPROVED DRAWINGS, THE INSTALLATION SHALL BE SUBJECT TO THE APPROVAL OF THE STRUCTURAL ENGINEER OF RECORD AND THE DSA DISTRICT STRUCTURAL ENGINEER. THE PROJECT INSPECTOR SHALL VERIFY THAT ALL COMPONENTS AND EQUIPMENT HAVE BEEN ANCHORED IN ACCORDANCE WITH THE ABOVE REQUIREMENTS.

PIPING, DUCTWORK AND ELECTRICAL SYSTEM DISTRIBUTION SYSTEM BRACING NOTE

PIPING, DUCTWORK AND ELECTRICAL DISTRIBUTION SYSTEMS SHALL BE BRACED TO COMPLY WITH THE FORCES AND DISPLACEMENTS PRESCRIBED IN ASCE 7-10, SECTION 13.3 AS DEFINED IN ASCE 7-10 SECTION 13.6.8, 13.6.7 AND 13.6.5.6, AND 2016 CBC SECTIONS 1616A.1.23 THROUGH 1615A.1.26. BRACING AND ATTACHMENT TO THE STRUCTURE SHALL BE DETAILED ON APPROVED DRAWINGS OR THEY SHALL COMPLY WITH ONE OF THE OSHPD PRE-APPROVALS (OPA#) AS MODIFIED TO SATISFY ANCHORAGE REQUIREMENTS OF ACI 318, APPENDIX D.

COPIES OF THE MANUAL SHALL BE AVAILABLE ON THE JOBSITE PRIOR TO THE START OF HANGING AND BRACING OF THE PIPE, DUCTWORK AND LEV. / LVL ELECTRICAL DISTRIBUTION SYSTEMS. THE STRUCTURAL ENGINEER OF RECORD SHALL VERIFY ADEQUACY OF THE STRUCTURE TO SUPPORT THE

ABBREVIATIONS

M.D.F.

AGG.

M.SUITE / M.S.

MEMBERS

MANUFACTURER

NOT IN CONTRACT

MASTER SUITE

NOT TO SCALE

ON CENTER

NATIONAL

MEDIUM-DENSITY FIBERBOARD

OWNER-FURNISHED, CONTRACTOR-INSTALLED

ANCHOR BOLT ASPHALT CONCRETE ACCESSIBLE ADDITIONAL ADJUSTED HEIGHT ABOVE FINISH FLOOR AGGREGATE ALTERNATE ALUMINUM AMPERE OR AMPERAGE

CONSTRUCTION CHANGE DOCUMENT

APPROXIMATE

BLOCKING

BOTTOM

BETWEEN

CAST IRON

CENTER LINE

CONCRETE

CASEMENT

DEMOLISH

DIAMETER

EXISTING

ELECTRICAL

EXTERIOR

FLOOR DRAIN

FOUNDATION

FUEL GAS

FLOOR JOIST

FLASHING

FLOOR

FOOTING

GAUGE

GALVANIZED

GLUE-LAMINATED

GYPSUM BOARD

HOSE BIBB

HOLD DOWN

HORIZONTAL

INFORMATION

INSULATION

LIGHTWEIGHT

INTERIOR

LEVEL

GALVANIZED SHEET METAL

HORIZONTAL METAL FRAME

EXPANSION JOINT

EXTRUDED POLYSTYRENE FOAM

GROUND FAULT CIRCUIT INTERRUPTER

DOUBLE PLATE

DRINKING FOUNTAIN

CONTRACTOR

ABOVE SEA LEVE

BELOW FINISH FLOOR

BUILT-UP ROOFING

CEMENT PLASTER

CONSTRUCTION IOINT

CONCRETE MASONRY UNIT

ADJ. HT.

ALUM.

APPROX.

BLK'G / BLKNG

BTM. / BOTT.

(D) OR DEMO

DET. OR DTI

F.J. / FLR. JST.

ASTM

N.I.C. AMERICAN SOCIETY OF TESTING MATERIALS

OPPOSITE HAND **PUSH BUTTON** PERFORATED PLATE HEIGHT POUNDS PER SQUARE INCH PRESSURE TREATED PWDR. POWDER RECOM. R.W. / RWD

RECOMMENDATION REINFORCING ROOM REDWOOD SELF-ADHESIVE FLASHING SEE ARCHITECTURAL DRAWINGS SEE CIVIL DRAWINGS SCHED. SMOKE DETECTOR S.E.D. SEE ELECTRICAL DRAWINGS S.F. / SQ. FT SQUARE FOOT S.L.D. S.M.D. S.P.D.

STOR.

STR1

T.O.F.

T.O.G.B.

T.O.W.

T.O.P. / T/P

SEE LANDSCAPE DRAWINGS SEE MECHANICAL DRAWINGS SEE PLUMBING DRAWINGS SQUARE INCH SEE STRUCTURAL DRAWINGS STORAGE STRUCTURAL 1 SHEAR WALL OR SWITCH S3S / S4S TEMP. / T TEMPERED THRESHOLD T. / THERM THERMOSTAT

SMOOTH 3 OR 4 SIDES TOP OF FLOOR TOP OF GRADE BEAM TOP OF PLATE TOP OF PLATE TOP OF SLAB TOP OF WALL THERMOPLASTIC POLYOLEFIN TONGUE AND GROOVE UNLESS NOTED OTHERWISE **VOLTS OR VOLTAGE** VERIFY IN FIELD WROUGHT IRON

WEATHERPROOF

WELDED WIRE FABRIC


WELDED WIRE MESH

WASHER / DRYER


POUND OR NUMBER

WEEP SCREED

PROJECT LOCATION

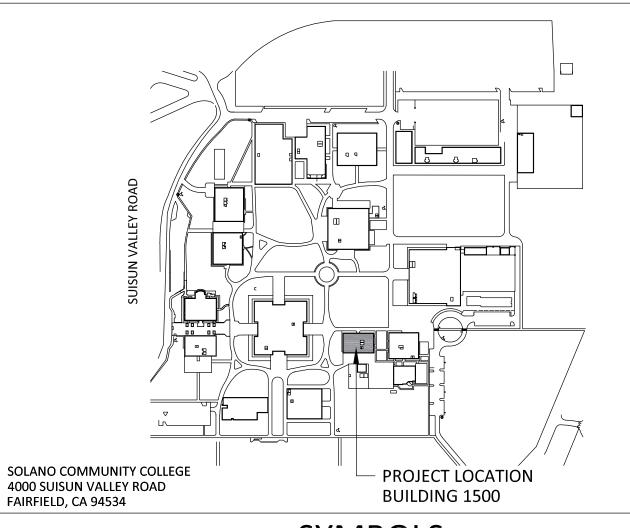

SYMBOLS

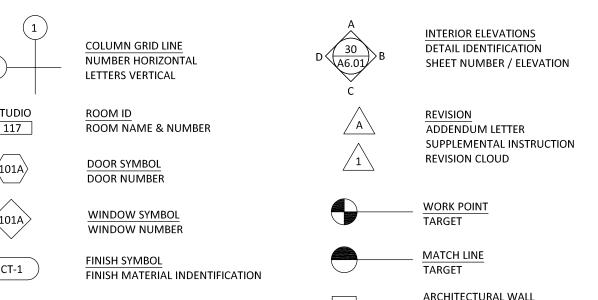

SECTION IDENTIFICATION SHEET NUMBER

DETAIL REFERENCE DETAIL IDENTIFICATION

SHEET NUMBER

ELEVATION TAG

PANEL SYMBOL

SCOPE OF WORK

SCOPE OF WORK INCLUDES, BUT IS NOT LIMITED TO THE FOLLOWING

1. DEMOLITION OF (E) ROOFING AND RE-ROOFING AT EXISTING BUILDING 1500.

DEFERRED APPROVALS

THE FOLLOWING ITEMS SHALL BE SUBMITTED FOR DEFERRED APPROVAL

NONE

SHEET LIST

STATEMENT OF GENERAL CONFORMANCE

THESE DRAWINGS AND/OR SPECIFICATIONS AND/OR CALCULATIONS LISTED BELOW HAVE BEEN PREPARED BY OTHER DESIGN PROFESSIONALS C CONSULTANTS WHO ARE LICENSED AND/OR AUTHORZIED TO PREPARE SUCH DRAWINGS IN THIS STATE. THESE DOCUMENTS HAVE BEEN

ITEMS LISTED BELOW ARE ACCEPTABLE FOR INCORPORATION INTO THE CONSTRUCTION OF THIS PROJECT FOR WHICH I AM THE INDIVIDUAL

LIST OF ITEMS REVIEWED AND ACCEPTED: ALL ITEMS IN THE SHEET INDEX, EXCEPT ARCHITECTURAL DRAWINGS.

8/18/17 C-35630 **EXPIRATION DATE** LICENSE NUMBER

DETAILS

ARCHITECT

303 POTRERO STREET, SUITE 7B I SANTA CRUZ, CA 95060

450 CHADBOURNE ROAD, SUITE G | FAIRFIELD, CA 9453 WWW.MADI-ARCH.COM

P I 800.725.0571

OWNER



FAIRFIELD, CA 94534 CONSULTANT

PROFESSIONAL STAMP:



RE-ROOFING OF

BUILDING 1500

4000 SUISUN VALLEY ROAD, BLDG 1500

FAIRFIELD, CA 94534 **ISSUE DATES** DATE DESCRIPTION BID SET 8/21/17 PROJECT CODE: SCCD-11 START DATE: 6/1/17 DRAWN BY:

SHEET NAME:

CHECKED BY:

AGENCY APPROVAL:

SHEET NUMBER:

GENERAL NOTES

- A. ALL EXISTING EQUIPMENT ON ROOF TO REMAIN. CONTRACTOR IS RESPONSIBLE FOR MAINTAINING THE INTEGRITY OF ALL EQUIPMENT UTILITY LINES AND OTHER DEVICES EXISTING ON THE ROOF
- B. CONTRACTOR IS REQUIRED TO VERIFY ALL EXISTING EQUIPMENT AND CONDITIONS ON THE ROOF.
- C. CONTRACTOR IS REQUIRED TO VERIFY ALL DIMENSIONS
- D. CONTRACTOR IS REQUIRED TO NOTIFY THE OWNER, ITS REPRESENTATIVE & THE ARCHITECT PRIOR TO DISCONNECTING ANY EXISTING EQUIPMENT AND/OR UTILITY LINES. PROVIDE MINIMUM OF 48-HOUR WRITTEN NOTICE PRIOR TO DISCONNECTING.
- E. CONTRACTOR IS RESPONSIBLE FOR STAGING, FENCING AND SECURITY OF ALL MATERIALS AND EQUIPMENT.
- F. REMOVE EXISTING BUILT UP ROOF TO EXISTING SLOPED PLYWOOD SHEATHING. CLEAN ROOF AND REMOVE ANY DEBRIS, NAILS AND OTHER APPURTENANCES PRIOR TO INSTALLING NEW ROOF.
- G. IT IS THE CONTRACTORS RESPONSIBILITY TO NOTIFY THE OWNER, OWNERS REPRESENTATIVE & ARCHITECT OF ANY EXISTING DEFORMITIES SUCH AS MOLD, DRY ROT ETC. STRUCTURAL DEFICIENCIES IN EXISTING STRUCTURE REVEALED DURING THE DEMOLITION PHASE WILL NEED TO ADDRESSED BY THE STRUCTURA ENGINEER AND MAY REQUIRE APPROVAL OF DIVISION OF STATE ARCHITECT (DSA). IN SUCH CASES, CONTRACTOR IS REQUIRED TO PROCEED WITH THAT PORTION OF WORK ONLY AFTER WRITTEN APPROVAL BY THE STRUCTURAL ENGINEER AND/OR DSA. THIS DETERMINATION WILL BE MADE BY THE ARCHITECT AND ITS ENGINEER AND THE CONTRACTOR WILL BE PROVIDED A WRITTEN DIRECTIVE ON REMEDYING THE DEFICIENCY. ANY WORK CARRIED OUT PRIOR TO OR WITHOUT APPROVAL OF ENGINEER OR DSA (AS CASE MAY BE), WILL BE AT RISK. THE OWNER, ITS REPRESENTATIVE AND THE ARCHITECT (AND ITS ENGINEERS) WILL NOT BE RESPONSIBLE FOR ANY COSTS INCURRED FOR NON-COMPLIANT WORK CARRIED OUT WITHOUT THE EXPRESS APPROVAL OF THE ENGINEER OR DSA.
- H. PROVIDE PRECAST CONCRETE SPLASH BLOCK AT ALL EXISTING AND NEW DOWNSPOUTS THAT ARE DAYLIGHTED TO PAVEMENT AND LANDSCAPED AREAS. SPLASH BLOCKS TO SLOPE AWAY FROM BUILDING. AVOID PLACEMENT OF SPLASH BLOCKS WHERE IT DIRECTLY INTERFERES WITH PATH OF TRAVEL OR POSES A HAZARD. SPLASH BLOCKS TO HAVE MINIMUM DIMENSION OF 20"L X 12"W X 3"H. PROVIDE CUT SHEETS AND SAMPLE OF SPLASH BLOCK AS PART OF SUBMITTAL PROCESS.
- . ALL EXISTING PIPING, CONDUIT, OR STRUCTURAL PENETRATIONS THROUGH ROOF ARE TO BE FLASHED PER ROOFING MFR'S STANDARD DETAILS.


ARCHITECT

ARCHITECTURE + PLANNING

303 POTRERO STREET, SUITE 7B I SANTA CRUZ, CA 95060 40 SOUTH FIRST STREET, SUITE 40A | SAN JOSE, CA 95113 450 CHADBOURNE ROAD, SUITE G | FAIRFIELD, CA 94534

> WWW.MADI-ARCH.COM PI 800.725.0571

OWNER

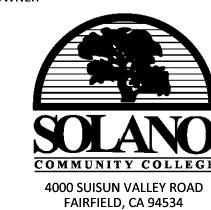

CONSULTANT

PROFESSIONAL STAMP:



PROJECT:

RE-ROOFING OF BUILDING 1500

4000 SUISUN VALLEY ROAD, BLDG 1500

FAIRFIELD, CA 94534 **ISSUE DATES**

REV	DESCRIPTION	DATE
-	BID SET	8/21/17
PROJECT CODE:		SCCD-11
START DATE:		6/1/17
DRAWN BY:		XX

SHEET NAME:

CHECKED BY:

ROOF PLAN -DEMO

AGENCY APPROVAL:

SHEET NUMBER:

SCALE: 1/8"=1'-0"

PARAPET CAP AND CANT. TYP.,

ALL AROUND

B. CONTRACTOR IS REQUIRED TO VERIFY ALL EXISTING EQUIPMENT

C. CONTRACTOR IS REQUIRED TO VERIFY ALL DIMENSIONS

REPRESENTATIVE & THE ARCHITECT PRIOR TO DISCONNECTING ANY EXISTING EQUIPMENT AND/OR UTILITY LINES. PROVIDE MINIMUM OF 48-HOUR WRITTEN NOTICE PRIOR TO DISCONNECTING.

E. CONTRACTOR IS RESPONSIBLE FOR STAGING, FENCING AND SECURITY OF ALL MATERIALS AND EQUIPMENT.

F. REMOVE EXISTING BUILT UP ROOF TO EXISTING SLOPED PLYWOOD SHEATHING. CLEAN ROOF AND REMOVE ANY DEBRIS, NAILS AND OTHER APPURTENANCES PRIOR TO INSTALLING NEW ROOF.

H. PROVIDE PRECAST CONCRETE SPLASH BLOCK AT ALL EXISTING AND NEW DOWNSPOUTS THAT ARE DAYLIGHTED TO PAVEMENT AND LANDSCAPED AREAS. SPLASH BLOCKS TO SLOPE AWAY FROM BUILDING. AVOID PLACEMENT OF SPLASH BLOCKS WHERE IT DIRECTLY INTERFERES WITH PATH OF TRAVEL OR POSES A HAZARD. SPLASH BLOCKS TO HAVE MINIMUM DIMENSION OF 20"L X 12"W X 3"H. PROVIDE CUT SHEETS AND SAMPLE OF SPLASH BLOCK AS PART OF SUBMITTAL PROCESS.

KEYNOTES

DRAIN & RIDGE MIN. 2" ABOVE DRAIN RIM, V.I.F.

DURING CONSTRUCTION & FLUSH AT COMPLETION OF WORK

(E) MECHANICAL SCREEN TO REMAIN, TYP. PROVIDE MFR'S STANDARD FLASHING BOOTS @ STANCHIONS SIM. TO DETAIL 3/A8.1

5 (N) PARAPET CAP, TYP. SEE DETAIL 1/A8.1

8 (E) ROOF HATCH TO REMAIN, SIM. TO DETAIL 4/A8.1

A. ALL EXISTING EQUIPMENT ON ROOF TO REMAIN. CONTRACTOR IS RESPONSIBLE FOR MAINTAINING THE INTEGRITY OF ALL EQUIPMEN

AND CONDITIONS ON THE ROOF.

D. CONTRACTOR IS REQUIRED TO NOTIFY THE OWNER, ITS

G. IT IS THE CONTRACTORS RESPONSIBILITY TO NOTIFY THE OWNER, OWNERS REPRESENTATIVE & ARCHITECT OF ANY EXISTING DEFORMITIES SUCH AS MOLD, DRY ROT ETC. STRUCTURAL DEFICIENCIES IN EXISTING STRUCTURE REVEALED DURING THE DEMOLITION PHASE WILL NEED TO ADDRESSED BY THE STRUCTURAL ENGINEER AND MAY REQUIRE APPROVAL OF DIVISION OF STATE ARCHITECT (DSA). IN SUCH CASES, CONTRACTOR IS REQUIRED TO PROCEED WITH THAT PORTION OF WORK ONLY AFTER WRITTEN APPROVAL BY THE STRUCTURAL ENGINEER AND/OR DSA. THIS DETERMINATION WILL BE MADE BY THE ARCHITECT AND ITS ENGINEER AND THE CONTRACTOR WILL BE PROVIDED A WRITTEN DIRECTIVE ON REMEDYING THE DEFICIENCY. ANY WORK CARRIED OUT PRIOR TO OR WITHOUT APPROVAL OF ENGINEER OR DSA (AS CASE MAY BE), WILL BE AT RISK. THE OWNER, ITS REPRESENTATIVE AND THE ARCHITECT (AND ITS ENGINEERS) WILL NOT BE RESPONSIBLE FOR ANY COSTS INCURRED FOR NON-COMPLIANT WORK CARRIED OUT WITHOUT THE EXPRESS APPROVAL OF THE ENGINEER OR DSA.

ALL EXISTING PIPING, CONDUIT, OR STRUCTURAL PENETRATIONS THROUGH ROOF ARE TO BE FLASHED PER ROOFING MFR'S STANDARD DETAILS.

(N) TPO ROOFING SYSTEM, TYP. THROUGHOUT. SEE DETAIL 1/A8.1

2 (N) SLOPED PLYWOOD CRICKET, TYP. MIN. 1/4" SLOPE TOWARDS

3 (E) ROOF DRAIN TO REMAIN, TYP. SEE DETAIL 2/A8.1. PROTECT

6 (N) TPO WALK PADS, TYP. LOCATE AS SHOWN. APPLY PER MFR'S INSTRUCTIONS

7 (E) CURB-MOUNTED MECHANICAL EQUIPMENT TO REMAIN, TYP. SEE DETAIL 4/A8.1

9 (E) CURB-MOUNTED HVAC EQUIPMENT TO REMAIN, SEE DETAIL 5/A8.1


ARCHITECT

ARCHITECTURE + PLANNING

303 POTRERO STREET, SUITE 7B I SANTA CRUZ, CA 95060 40 SOUTH FIRST STREET, SUITE 40A | SAN JOSE, CA 95113 450 CHADBOURNE ROAD, SUITE G | FAIRFIELD, CA 94534

> WWW.MADI-ARCH.COM PI 800.725.0571

OWNER

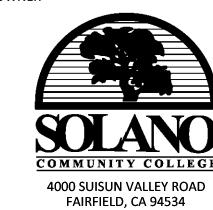

CONSULTANT



PROJECT:

RE-ROOFING OF BUILDING 1500

4000 SUISUN VALLEY ROAD, BLDG 1500 FAIRFIELD, CA 94534

SSUE I	DATES	
REV	DESCRIPTION	8/21/17
-	BID SET	8/21/17
ROJECT CODE:		SCCD-11
TART DATE:		6/1/17
RAWN BY:		XX
HECKED BY:		XX

SHEET NAME:

ROOF PLAN - NEW

AGENCY APPROVAL:

SHEET NUMBER:

SCALE: 1/8"=1'-0"

8'-0"

15'-10"

15'-10"

(E) SLOPE

(E) SLOPE

15'-10"

130'-4"

12**'**-0"

15'-10"


15'-10"

(E) SLOPE

(E) SLOPE

8'-0"

15**'**–10"

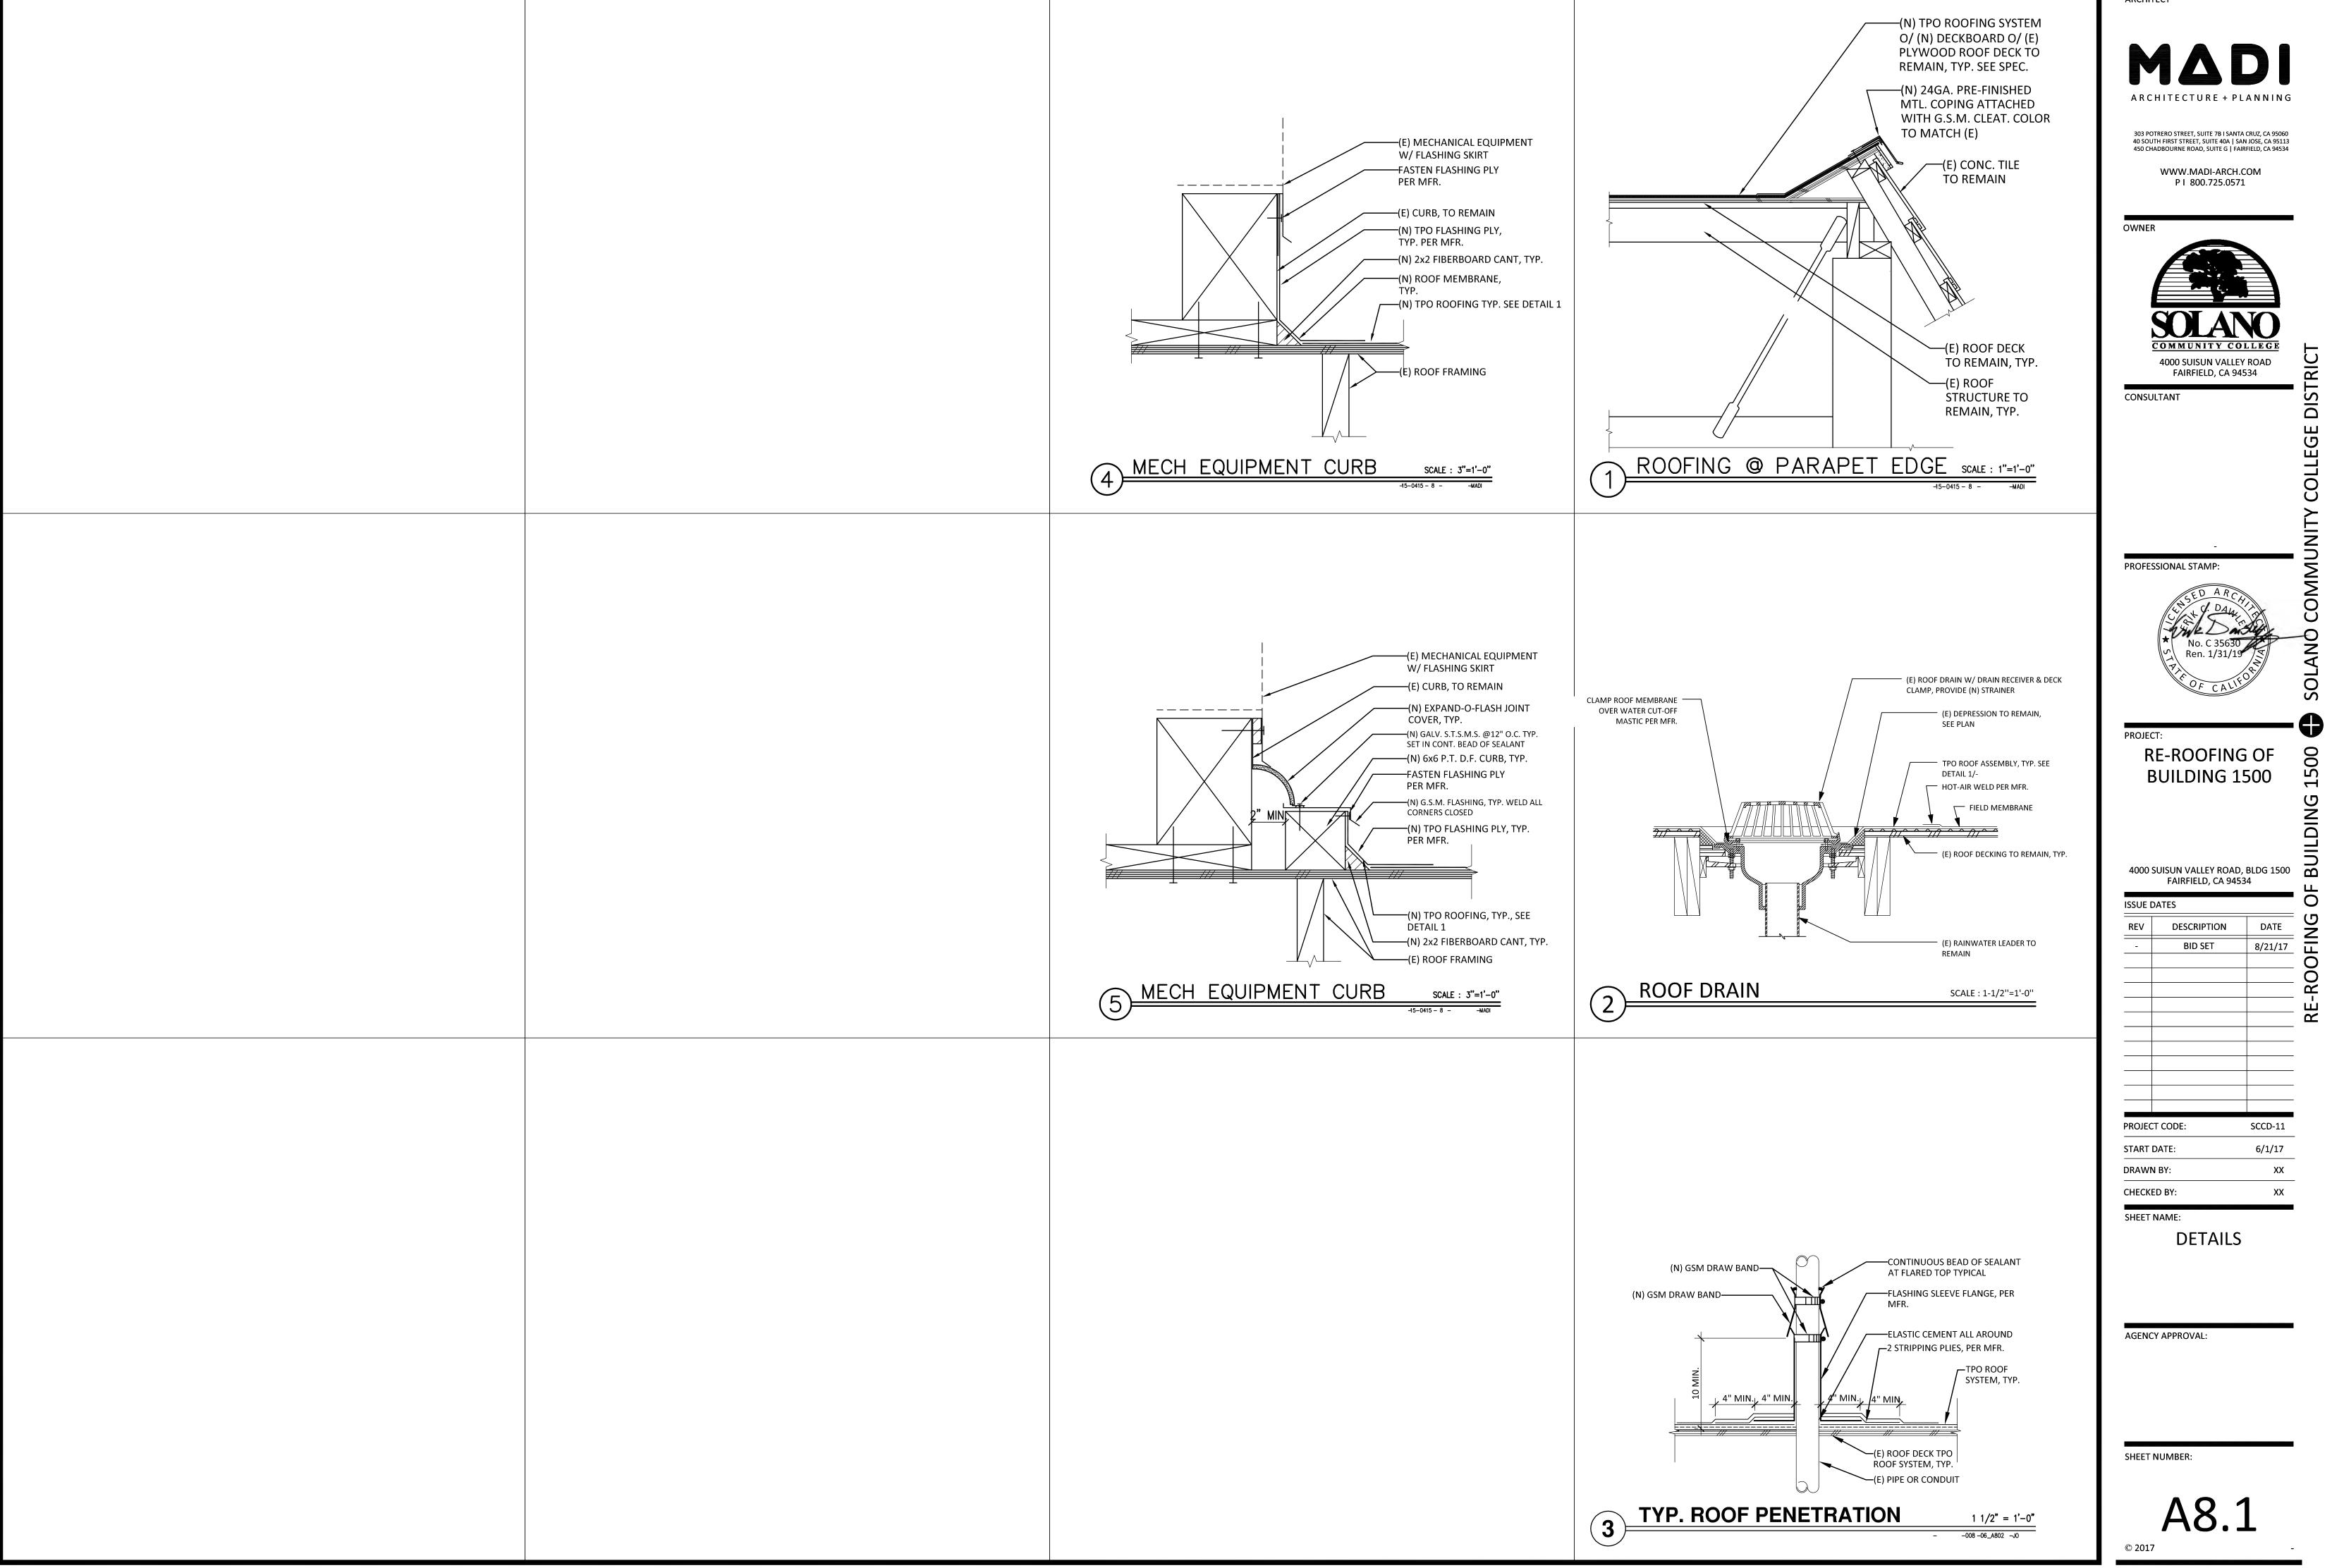

ARCHITECT